


UD2466 DOUBLE STOREY GRANNY FLAT - DA APPLICATION

84 LANCASTER AVENUE PUNCHBOWL 2196 | LOT 33 DP 11831 PREPARED FOR - JOSEPH MOKDASSI

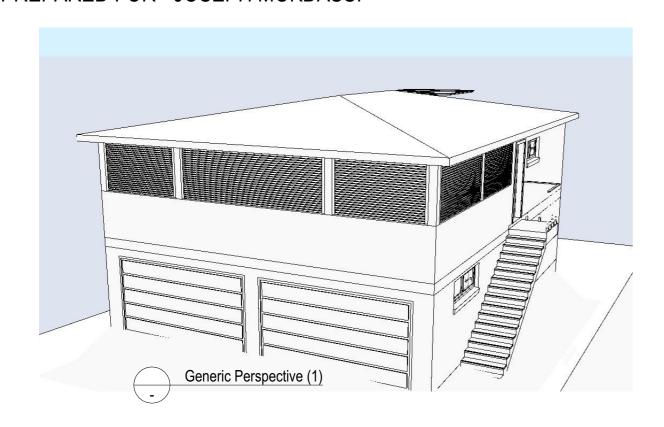

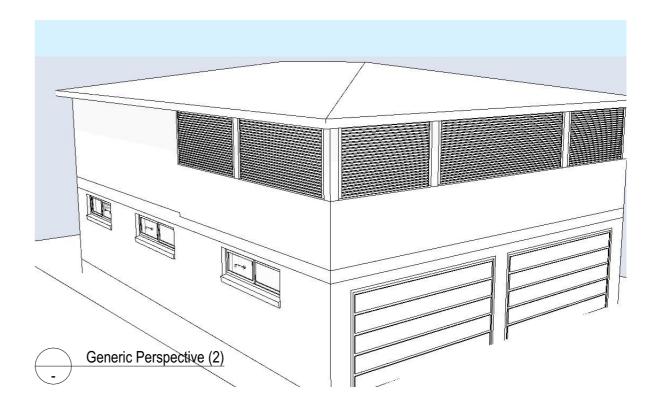

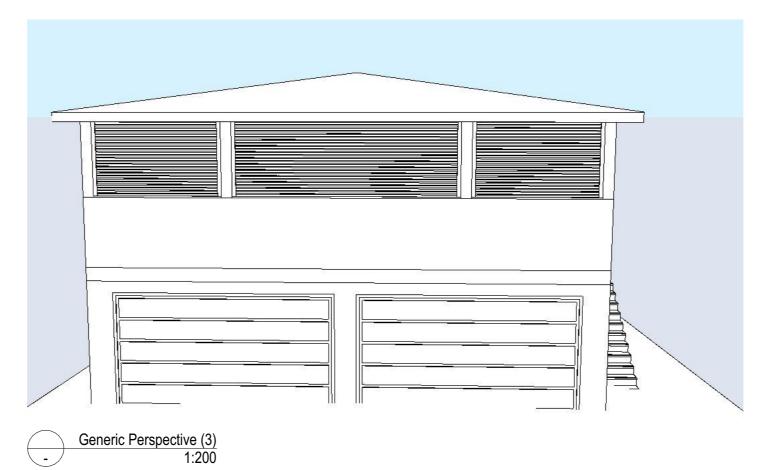




COUNCIL DEVELOPMENT CONTROLS - SECONDAR	RY DWELLIN	IG	
CONTROLS	REQ'D	PROPOSED	COMPLIES
LOT SIZE M ²	450m²	935.8m ²	YES
SECONDARY DWELLING MAX FLOOR AREA	60m ²	60m ²	YES
MAXIMUM HEIGHT (as per DCP definition) The storey limit for attached secondary dwellings is 2 storeys	2	2	YES
MAX FLOOR SPACE RATIO	0.5:1	0.35:1	YES
SETBACKS FROM SIDE BOUNDARIES LHS RHS	0.9m 0.9m	0.9m 2.3m	YES YES
SETBACKS FROM REAR BOUNDARY	0.9m	6m	YES
LANDSCAPED AREA REQ'D M ²	N/A	301m ²	YES
PRIVATE OPEN SPACE (as defined by Sepp) Secondary dwelling must not result in principal dwelling on site having less than the required landscaped area and private open space			YES
MAX ROOF PITCH	35°	15°	YES

SITE PLAN LEGEND
CUT
FILL
BATTER
PROPOSED DRIVEWAY
LANDSCAPING FRONT OF BUILDING LINE
LANDSCAPING BEHIND BUILDING LINE

FLOOR AREA	
SECONDARY DWELLING	59.36
ALFRESCO	45.73
GARAGE	111.13
PRINCIPLE DWELLING	121.19
	337.41 m ²



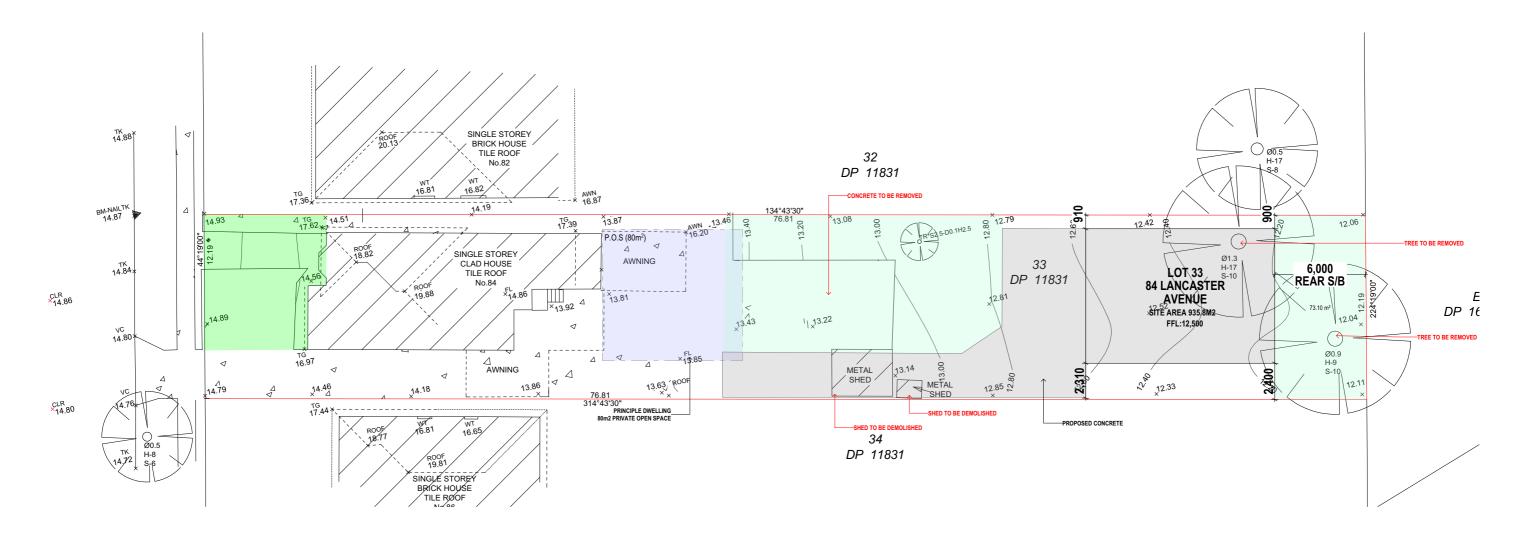



All boundaries and contours are subject to survey drawing. All levels to Australian

Height Data. It is the contractors responsibility to confirm all measurements on site and locations of any services prior to work on site.



UNIVERSAL DESIGNS

Designer: Matthew Mina matthew@universaldesigns.com.au

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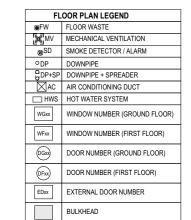
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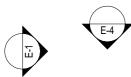
JOSEPH MOKDASSI PROJECT: DOUBLE STOREY GRANNY FLAT LOT 33 DP 11831 84 LANCASTER AVENUE PUNCHBOWL 2196


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A3









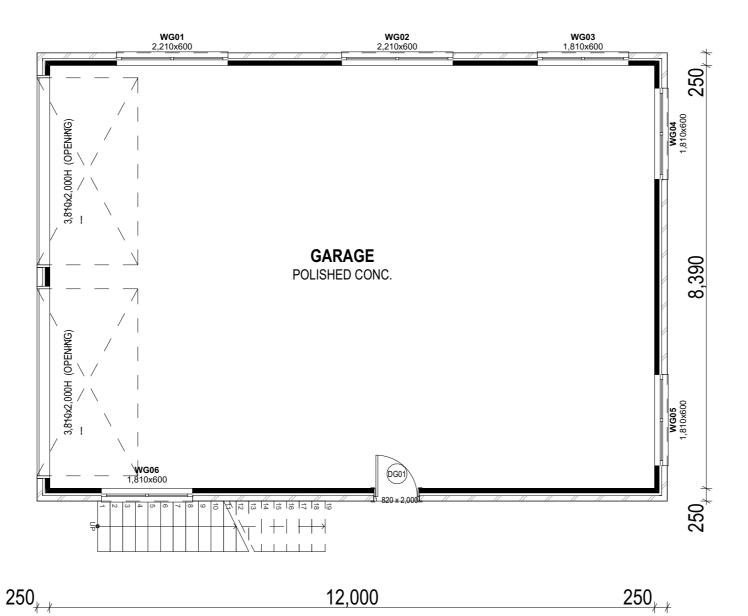



FLOOR AREA		
SECONDARY DWELLING	59.36	
ALFRESCO	45.73	
GARAGE	111.13	
PRINCIPLE DWELLING	121.19	
	337.41 m ²	



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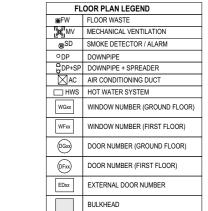
GROUND FLOOR PLAN

CLIENT: JOSEPH MOKDASSI


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LOT 33 DP 11831
84 LANCASTER AVENUE PUNCHBOWL 2196


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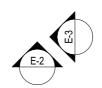






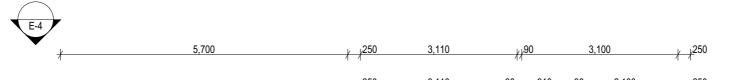

12,500 OVERALL

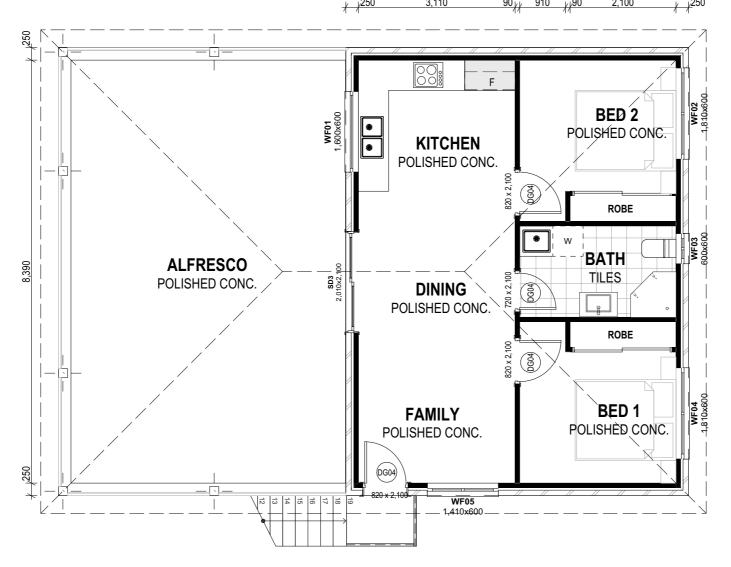

250

250

90 xx 510 xx90

1,810

8,890 OVERALL



FIRST FLOOR PLAN

1:75

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FIRST FLOOR PLAN

JOSEPH MOKDASSI PROJECT: DOUBLE STOREY GRANNY FLAT

LOT 33 DP 11831 84 LANCASTER AVENUE PUNCHBOWL 2196

FLOOR AREA		
SECONDARY DWELLING	59.36	
ALFRESCO	45.73	
GARAGE	111.13	
PRINCIPLE DWELLING	121.19	
	337.41 m ²	

DRAWN BY:

MM

SCALE: 1:75


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SHEET NO:


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ROOF PLAN 1:100



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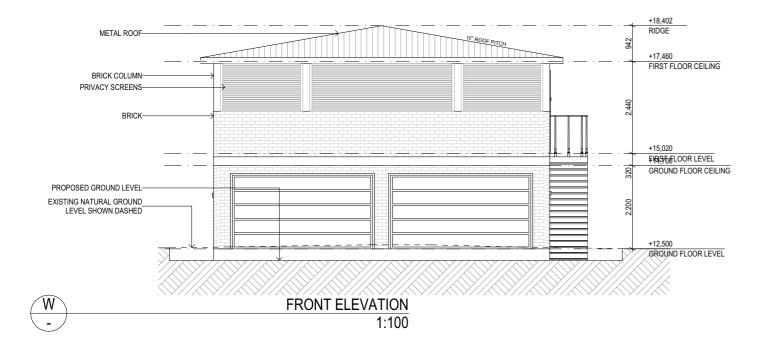
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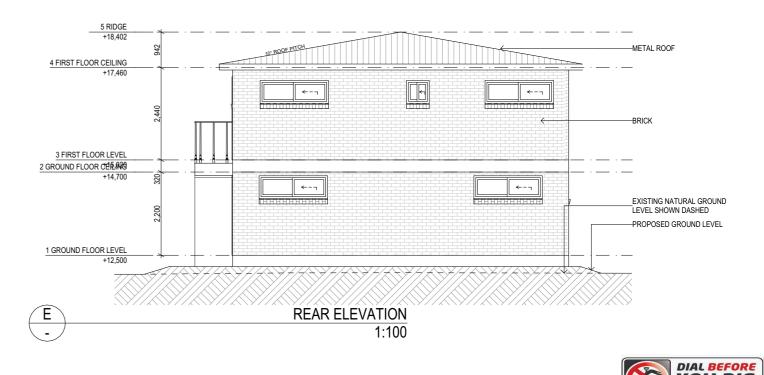
DRAWING: **ROOF PLAN**

JOSEPH MOKDASSI PROJECT:

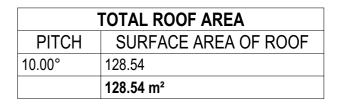DOUBLE STOREY GRANNY FLAT LOT 33 DP 11831 84 LANCASTER AVENUE PUNCHBOWL 2196
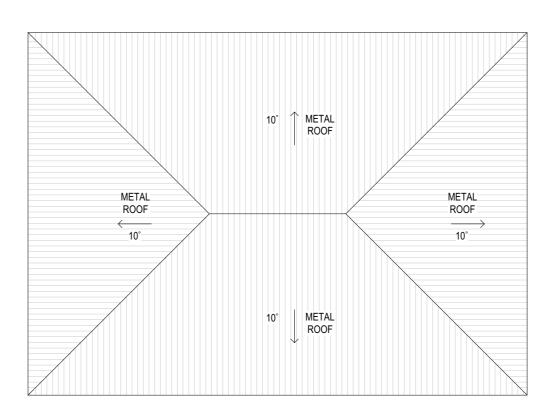
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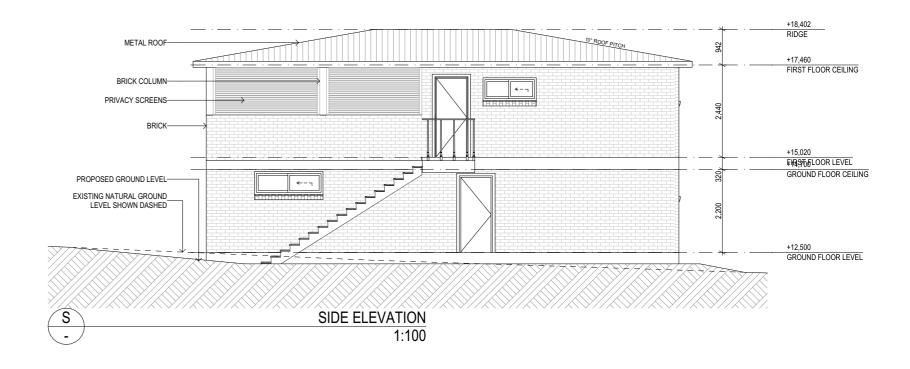
ELEVATIONS SHEET 1


.IENT :	JOSEPH MOKDASSI
ROJECT:	DOUBLE STOREY GRANNY FLAT
	LOT 33 DP 11831
	84 LANCASTER AVENUE PUNCHBOWL 2196

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SCALE: 1:100	APPLICATION : DA + CC	UD2466

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ELEVATIONS SHEET 2

CLIENT JOSEPH MOKDASSI PROJECT:

ī:	DOUBLE STOREY GRANNY FLAT
	LOT 33 DP 11831
	84 LANCASTER AVENUE PUNCHBOWL 219
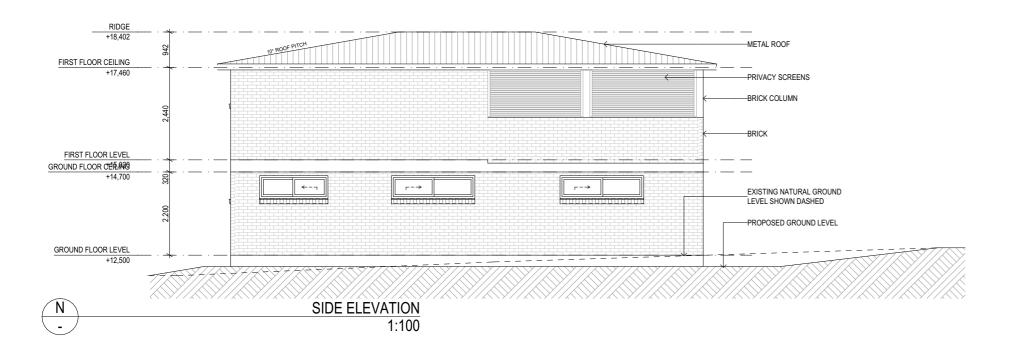
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00240		APPLICATION : DA + CC	SCALE: 1:100	
7	ISSUE	SHEET NO:	SHEETSIZE	
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	WINDOW SCHEDULE										
ID	WF01	WF02	WF03	WF04	WF05	WG01	WG02	WG03	WG04	WG05	WG06
View from Opening Side		←	Œ	<u>—</u>		\rightarrow	→	← 1	←	← ,	←
WxH	1,600×600	1,810×600	600×600	1,810×600	1,410×600	2,210×600	2,210×600	1,810×600	1,810×600	1,810×600	1,810×600
Quantity	1	1	1	1	1	1	1	1	1	1	1
Glass	Glass - Clear	Glass - Clear	Glass - Clear	Glass - Clear	Glass - Clear	Glass - Clear	Glass - Clear	Glass - Clear	Glass - Clear	Glass - Clear	Glass - Clear
W/D Nominal Sill Height	950	1,500	1,500	1,500	1,500	1,500	1,500	1,500	1,500	1,500	1,540
W/D Nominal Head Height	1,550	2,100	2,100	2,100	2,100	2,100	2,100	2,100	2,100	2,100	2,140



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ACCREDITED BUILDING DESIGNER

UNIVERSAL DESIGNS

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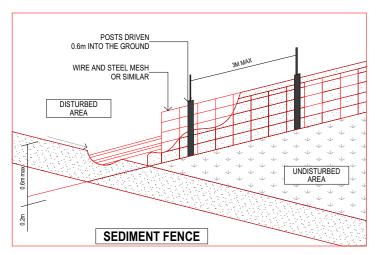
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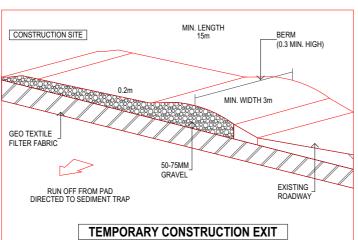
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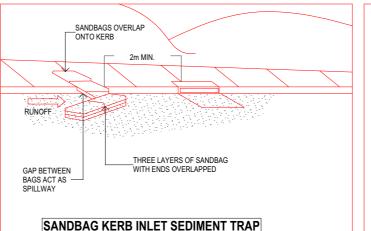
JOSEPH MOKDASSI

PROJECT: DOUBLE STOREY GRANNY FLAT LOT 33 DP 11831 84 LANCASTER AVENUE PUNCHBOWL 2196

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SCALE: 1:100, 1:1	APPLICATION : DA + CC		UD2466
SHEETSIZE A3	SHEET NO:	ISSUE	7







SEDIMENT CONTROL NOTES

- 1. ALL EROSION AND SEDIMENTATION CONTROL MEASURES, INCLUDING REVEGETATION AND STORAGE OF SOIL AND TOPSOIL, SHALL BE IMPLEMENTED TO THE STANDARDS OF THE SOIL CONSERVATION OF NSW.

 2. ALL DRAINAGE WORKS SHALL BE CONSTRUCTED AND STABILIZED AS EARLY AS POSSIBLE DURING

- 2. ALL DRAINAGE WORKS SHALL BE CONSTRUCTED AND STABILIZED AS EARLY AS POSSIBLE DURING DEVELOPMENT.

 3. SEDIMENT TRAPS SHALL BE CONSTRUCTED AROUND ALL INLET PITS, CONSISTING OF 300MM WIDE X 300DEEP TRENCH.


 4. ALL SEDIMENT BASINS AND TRAPS SHALL BE CLEANED WHEN THE STRUCTURES AREA MAXIMUM OF 60% FULL OF SOIL MATERIALS, INCLUDING THE MAINTENANCE PERIOD.

 5. ALL DISTURBED AREAS SHALL BE REVEGITATED AS SOON AS THE RELEVANT WORKS ARE COMPLETED.

 6. SOIL AND TOPSOIL STOCKPILES SHALL BE LOCATED AWAY FROM DRAINAGE LINES AND AREA WHERE WATER MAY CONCENTRATE.

 7. FILTER SHALL BE CONSTRUCTED BY STRETCHING A FILTER FABRIC (PROPEX OR APPROVED EQUIVALENT DETMICED DOCT AT 2 OR CENTRES CARPIC SHALL BE PLIBED 450MM ALONG TESLOWED.
- BETWEEN POST AT 3.0m CENTRES, FABRIC SHALL BE BURIED 150MM ALONG ITS LOWER

SEDIMENT CONTROL PLAN LEGEND				
	SITE FENCE			
<u> </u>	SEDIMENT FENCE			
PO	PORTALOO			

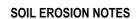

- 1. TOPSOIL SHALL BE STRIPPED AND STOCKPILED OUTSIDE HAZARD AREAS SUCH AS DRAINAGE LINES. THIS TOPSOIL IS TO BE RE-SPREAD LATER ON AREAS TO BE REVEGETATED AND STABILISED ONLY. (i.e ALL FOOT-PATHS, BATTERS, SITE, REGRADING AREAS, DRAINAGE RESERVES AND CHANNELS).

 2. TOP SOIL SHALL NOT BE SPREAD ON ANY OTHER AREAS SPECIFICALLY INSTRUCTED BY THE SUPERINTENDENT. IF
- THEY ARE TO REMAIN FOR LONGER THAN ONE MONTH STOCKPILES SHALL BE PROTECTED FROM FROSION BY COVERING THEM WITH A MULCH AND HYDROSEEDING AND, IF NECESSARY, BY LOCATING BANKS OR DRAINS UPSLOPE TO DIVERT THE RUNOFF AROUND THEM.
- IN SOME CIRCUMSTANCES IT MAY BE NECESSARY TO PLACE BANKS OR DRAINSDOWN STREAM OF A STOCKPILE TO RETARD SEDIMENT LADEN RUNOFF.
- 3. THE CONTRACTOR SHALL REGULARLY MAINTAIN ALL SEDIMENT AND EROSION CONTROL DEVICES AND REMOVE ACCUMULATED SILT FROM SUCH DEVICES BEFORE NO MORE THAN 60% OF THEIR CAPACITY IS LOST. 4. ALL THE SILT REMOVED SHALL BE DISPOSED OF AS DIRECTED BY THE SUPERINTENDENT. (NO SILT SHALL BE PLACED OUTSIDE THE LIMITS OF WORKS). THE PERIOD FOR MAINTAINING THESE DEVICES SHALL BE AT LEAST UNTIL ALL DISTURBED AREAS ARE REVEGETATED AND FURTHER AS MAY BE DIRECTED BY THE SUPERINTENDENT OR COUNCIL

NOTES

- 1. ALL EROSION AND SEDIMENT CONTROL MEASURES TO BE INSPECTED AND MAINTAINED DAILY BY CONTRACTOR / SITE MANAGER.
- 2 MINIMISE DISTURBED AREAS
- 2. ALL STOCKPILES TO BE CLEARED FROM DRAINS, GUTTERS AND FOOTPATHS.
 4. DRAINAGE IS TO BE CONNECTED TO STORMWATER SYSTEM AS SOON AS POSSIBLE.
- 5. ROADS AND FOOTPATH TO BE SWEPT DAILY
 6. UNDER SECTION 16 OF THE CLEAN WATERS ACT, HEAVY FINES, INCLUDING A \$600 ON THE SPOT FINE, MAY BE IMPOSED IF A PERSON ALLOWS SOIL, CEMENT SLURRY OR OTHER BUILDING MATERIALS TO BE PUMPED, DRAINED OR ALLOWED TO ENTER THE STORMWATER SYSTEM.

SEDIMENT FENCE NOTES

- 1. CONSTRUCT SEDIMENT FENCE AS CLOSE AS POSSIBLE AND PARALLEL TO THE CONTOURS OF THE SITE.
 2. DRIVE 1.5M LONG STAR PICKETS INTO GROUND MAX. 3M CTRS.
- 3. DIG A 150MM DEEP TRENCH ALONG THE UPSLOPE LINE OF THE FENCE FOR THE BOTTOM OF THE FABRIC TO BE ENTRENCHED
- 4. BACKFILL TRENCH OVER BASE OF FABRIC
- 5. FIX SELF SUPPORTING GEOTEXTILE TO UPSLOPE SIDE OF POSTS WITH WIRE TIES OR AS RECOMMENDED BY GEOTEXTILE MANUFACTURER
- 6. JOIN SECTIONS OF FABRIC AT A SUPPORT POST WITH A MIN. LAP OF 150MM.



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SEDIMENT CONTROL + SITE MANAGEMENT PLAN

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1 MATERIAL STORAGE


SEDIMENT CONTROL PLAN


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DOUBLE STOREY GRANNY FLAT LOT 33 DP 11831 84 LANCASTER AVENUE PUNCHBOWL 2196









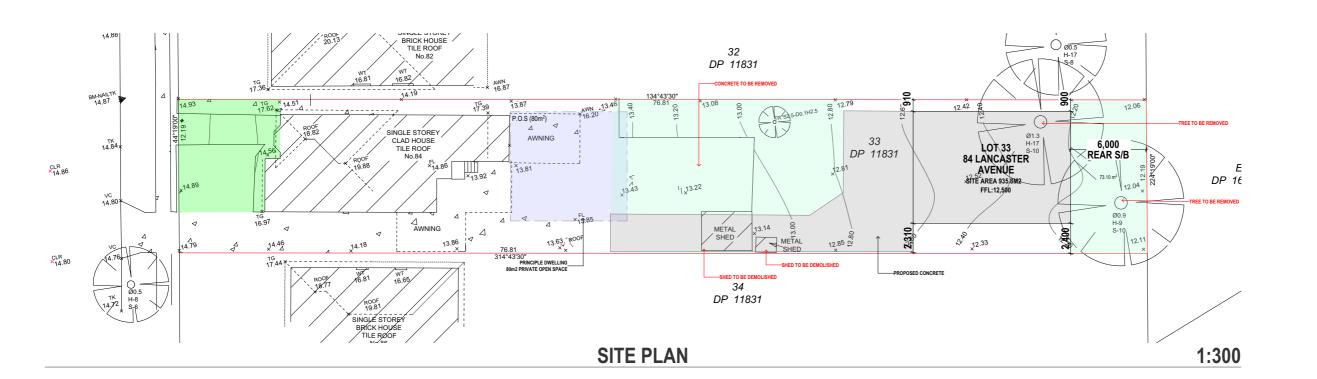

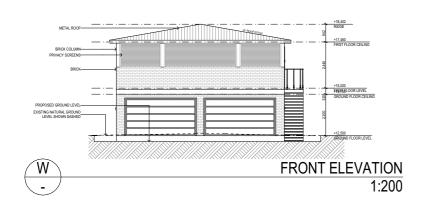

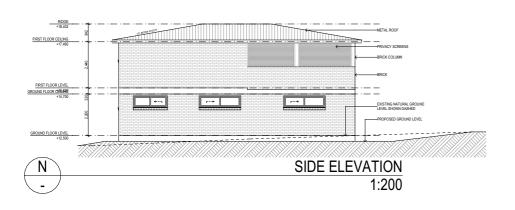

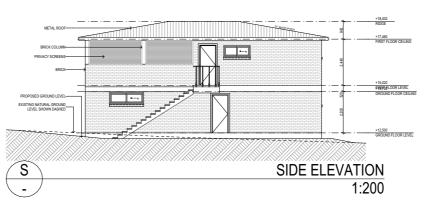

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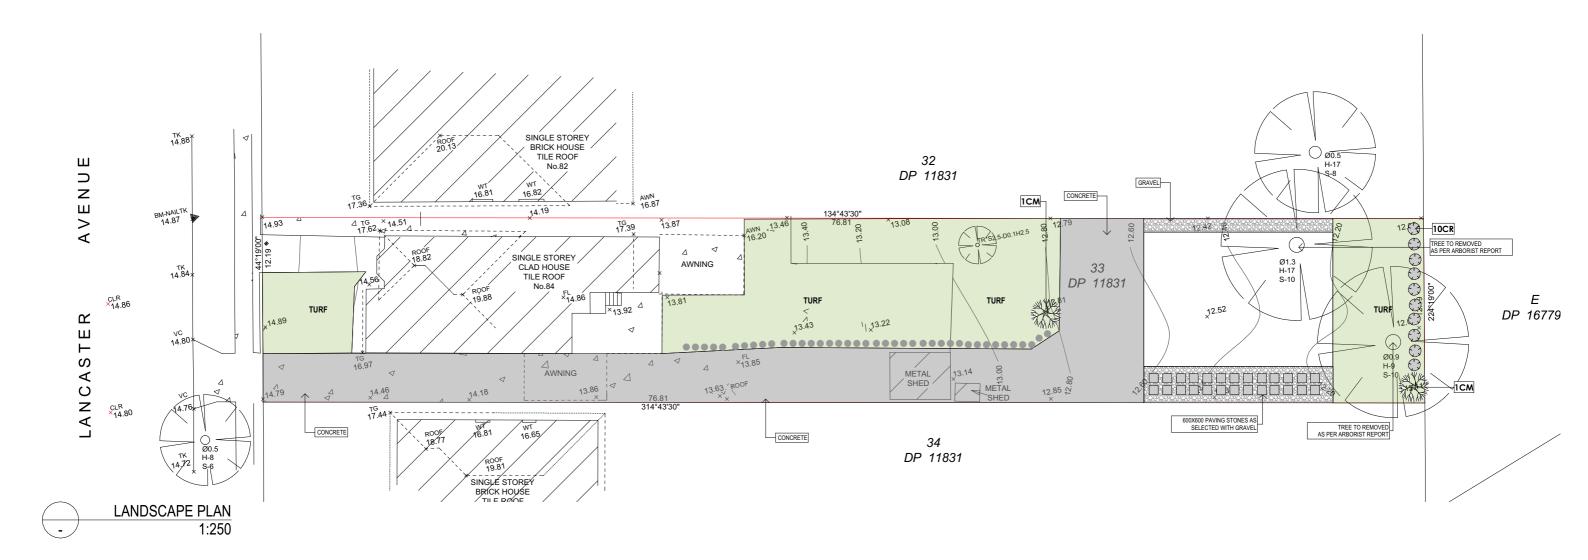
NOTIFICATION PLANS

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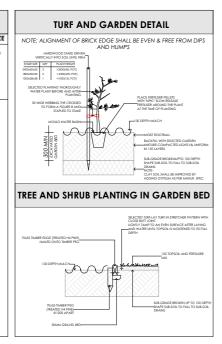
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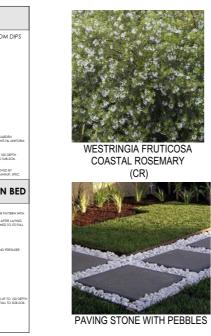
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PAVING STONE WITH



ZOYSIA NARA NATIVE TURF

"TUSCACORE" CREPE MYRTLE (CM)

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Height Data. It is the contractors responsibility to confirm all measurements on site and

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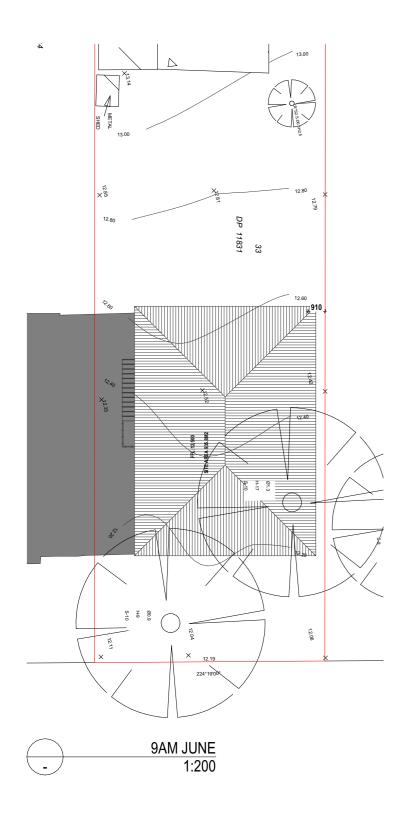
CONCEPT LANDSCAPE PLAN


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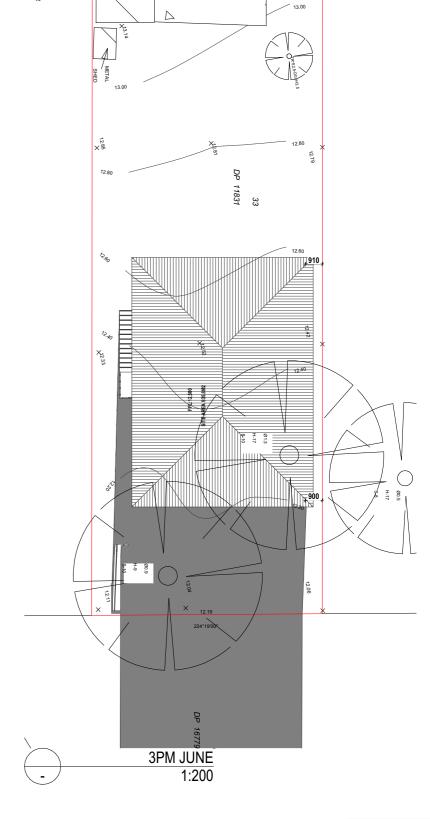
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Designer: Matthew Mina matthew@universaldesigns.com.au

7	30/09/2024	DA ISSUE - RFI
6	30/09/2024	DA ISSUE - RFI
5	18/08/2024	DA ISSUE
4	11/08/2024	CONCEPT DESIGN
3	03/08/2024	CONCEPT DESIGN
2	17/07/2024	CONCEPT DESIGN
1	13/07/2024	CONCEPT DESIGN

SHADOW DIAGRAMS

JOSEPH MOKDASSI DOUBLE STOREY GRANNY FLAT PROJECT:

LOT 33 DP 11831 84 LANCASTER AVENUE PUNCHBOWL 2196

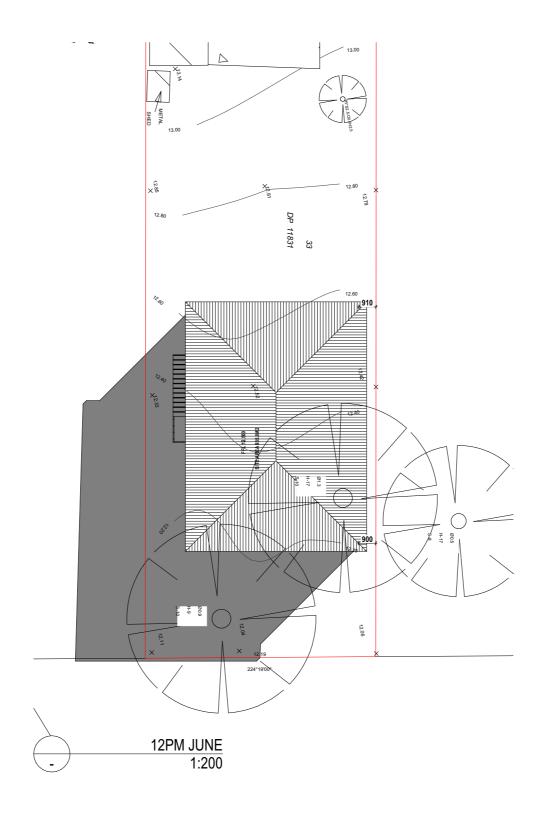	DIAL BEFORE YOU DIG www.1100.com.au
DATE :	JOB NO.

JOB NO.	DATE : 15/10/2024	DRAWN BY:	
	APPLICATION : DA + CC	SCALE: 1:200	
ISSUE	SHEET NO:	SHEETSIZE A3	
		15/10/2024 APPLICATION: DA + CC SHEET NO: ISSUE	MM 15/10/2024 SCALE: APPLICATION: 1:200 DA + CC SHEETSIZE SHEET NO: ISSUE

ROOF **COLORBOND ROOF**

MONUMENT


GUTTER


COLORBOND ROOF

MONUMENT

WINDOWS MONUMENT

BRICK ZEPHR COLOUR **GARAGE DOOR** PANEL LIFT MERBAU

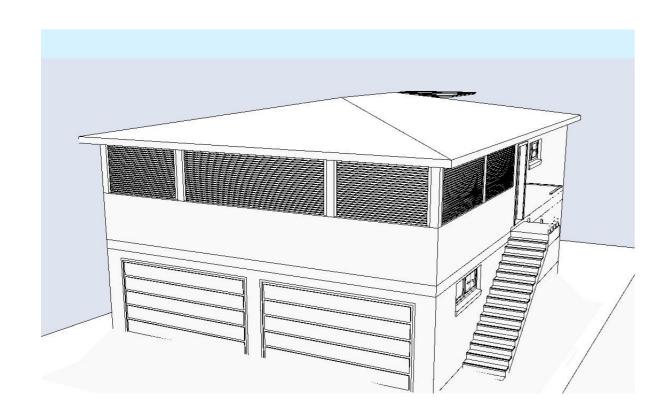

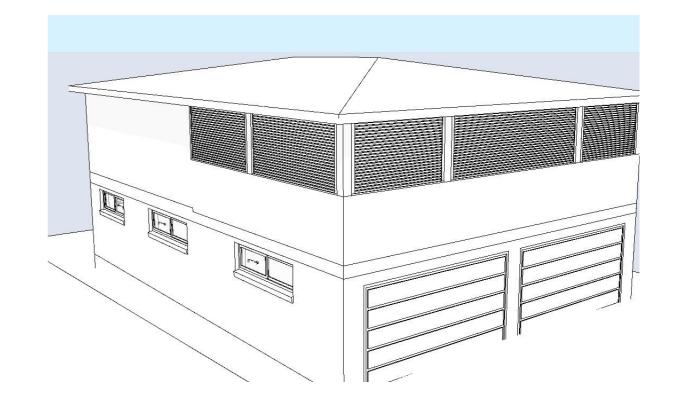



NOTE

The Builder shall check all dimensions and levels on site prior to construction. Notify any errors, discrepancies or omissions to the designer. Refer to written dimensions only. Do not scale drawings. Drawings shall not be used for construction purposes until issued for construction. This drawing reflects a design by Universal Designs and is to be used only for work when authorised in writing by Universal Designs

All boundaries and contours are subject to survey drawing. All levels to Australian Height Data. It is the contractors responsibility to confirm all measurements on site and locations of any services prior to work on site.



UNIVERSAL DESIGNS

Designer: Matthew Mina matthew@universaldesigns.com.au 30/09/2024 30/09/2024 18/08/2024 11/08/2024 03/08/2024 17/07/2024

DA ISSUE - RFI DA ISSUE - RFI DA ISSUE CONCEPT DESIGN CONCEPT DESIGN CONCEPT DESIGN CONCEPT DESIGN



EXTERNAL FINISHES

CLIENT: JOSEPH MOKDASSI PROJECT:

DOUBLE STOREY GRANNY FLAT LOT 33 DP 11831 84 LANCASTER AVENUE PUNCHBOWL 2196

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DRAWN BY: DATE: MM 15/10/2024 **UD2466** APPLICATION: SCALE: 1:250 DA + CC SHEETSIZE SHEET NO: A3 12